# PROPOSED WAREHOUSE 149-155 AIRDS ROAD, MINTO, NSW, 2566 CIVIL DRAWINGS FOR DEVELOPMENT APPLICATION

### DRAWING LIST:

DRAWING NO. DRAWING TITLE

CO14521.01-DA 2-10 DRAWING LIST & GENERAL NOTES

CO14521.01-DA 2-20 EROSION & SEDIMENT CONTROL PLAN

CO14521.01-DA 2-25 EROSION & SEDIMENT CONTROL DETAILS - SHEET 1
CO14521.01-DA 2-26 EROSION & SEDIMENT CONTROL DETAILS - SHEET 2

CO14521.01-DA 2-30 BULK EARTHWORKS PLAN

CO14521.01-DA 2-35 BULK EARTHWORKS SECTIONS

CO14521.01-DA 2-40 STORMWATER DRAINAGE PLAN

CO14521.01-DA 2-45 STORMWATER DRAINAGE DETAILS - SHEET 1

CO14521.01-DA 2-46 STORMWATER DRAINAGE DETAILS - SHEET 2

CO14521.01-DA 2-47 STORMWATER DRAINAGE DETAILS - SHEET 3

CO14521.01-DA 2-50 FINISHED LEVELS PLAN

CO14521.01-DA 2-51 TYPICAL SECTIONS

#### **GENERAL NOTES:**

- 1. THESE DRAWINGS SHALL BE READ IN CONJUNCTION WITH ALL ARCHITECTURAL AND OTHER CONSULTANTS' DRAWINGS AND SPECIFICATIONS AND WITH SUCH OTHER WRITTEN INSTRUCTIONS AS MAY BE ISSUED DURING THE COURSE OF THE CONTRACT. ANY DISCREPANCY SHALL BE REFERRED TO THE ENGINEER BEFORE PROCEEDING WITH THE WORK
- 2. ALL MATERIALS AND WORKMANSHIP SHALL BE IN ACCORDANCE WITH THE RELEVANT AND CURRENT STANDARDS AUSTRALIA CODES AND WITH THE BY-LAWS AND ORDINANCES OF THE RELEVANT BUILDING AUTHORITIES EXCEPT WHERE VARIED BY THE PROJECT SPECIFICATION.
- 3. ALL DIMENSIONS SHOWN SHALL BE VERIFIED BY THE BUILDER ON SITE.
  ENGINEER'S DRAWINGS SHALL NOT BE SCALED FOR DIMENSIONS.
  ENGINEER'S DRAWINGS ISSUED IN ANY ELECTRONIC FORMAT MUST NOT BE USED FOR DIMENSIONAL SETOUT.
  REFER TO THE ARCHITECT'S DRAWINGS FOR ALL DIMENSIONAL SETOUT INFORMATION
- 4. DURING CONSTRUCTION THE STRUCTURE SHALL BE MAINTAINED IN A STABLE CONDITION AND NO PART SHALL BE OVERSTRESSED. TEMPORARY BRACING SHALL BE PROVIDED BY THE BUILDER TO KEEP THE WORKS AND EXCAVATIONS STABLE AT ALL TIMES.
- 5. UNLESS NOTED OTHERWISE ALL LEVELS ARE IN METRES AND ALL DIMENSIONS ARE IN MILLIMETRES.
- 6. ALL WORKS SHALL BE UNDERTAKEN IN ACCORDANCE WITH ACCEPTABLE SAFETY STANDARDS & APPROPRIATE SAFETY SIGNS SHALL BE INSTALLED AT ALL TIMES DURING THE PROGRESS OF THE JOB.


#### **ELECTRONIC INFORMATION NOTES:**

- 1. THE ISSUED DRAWINGS IN HARD COPY OR PDF FORMAT TAKE PRECEDENCE OVER ANY ELECTRONICALLY ISSUED INFORMATION, LAYOUTS OR DESIGN MODELS.
- THE CONTRACTOR'S DIRECT AMENDMENT OR MANIPULATION OF THE DATA OR INFORMATION THAT MIGHT BE CONTAINED WITHIN AN ENGINEER-SUPPLIED DIGITAL TERRAIN MODEL AND ITS SUBSEQUENT USE TO UNDERTAKE THE WORKS WILL BE SOLELY AT THE DISCRETION OF AND THE RISK OF THE CONTRACTOR.
- 3. THE CONTRACTOR IS REQUIRED TO HIGHLIGHT ANY DISCREPANCIES BETWEEN THE DIGITAL TERRAIN MODEL AND INFORMATION PROVIDED IN THE CONTRACT AND/OR DRAWINGS AND IS REQUIRED TO SEEK CLARIFICATION FROM THE SUPERINTENDENT.
- 4. THE ENGINEER WILL NOT BE LIABLE OR RESPONSIBLE FOR THE POSSIBLE ON-GOING NEED TO UPDATE THE DIGITAL TERRAIN MODEL, SHOULD THERE BE ANY AMENDMENTS OR CHANGES TO THE DRAWINGS OR CONTRACT INITIATED BY THE CONTRACTOR.





# FOR DEVELOPMENT APPLICATION

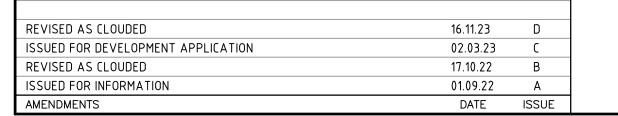







DESIGNED DRAWN DATE CHECKED SIZE SCALE CAD REF:
IL IL AUG '22 DS A1 AS SHOWN C014521.01-DA 2-10



Costin Roe Consulting Pty Ltd.
ABN 50 003 696 446


PO Box N419 Sydney NSW 1220 Level 4, 8 Windmill Street, Millers Point NSW 2000 p: +61 2 9251 7699 f: +61 2 9241 3731 e: mail@costinroe.com.au w: costinroe.com.au



CIVIL &
STRUCTURAL
ENGINEERS

DRAWING LIST & GENERAL NOTES

CO14521.01-DA2-10

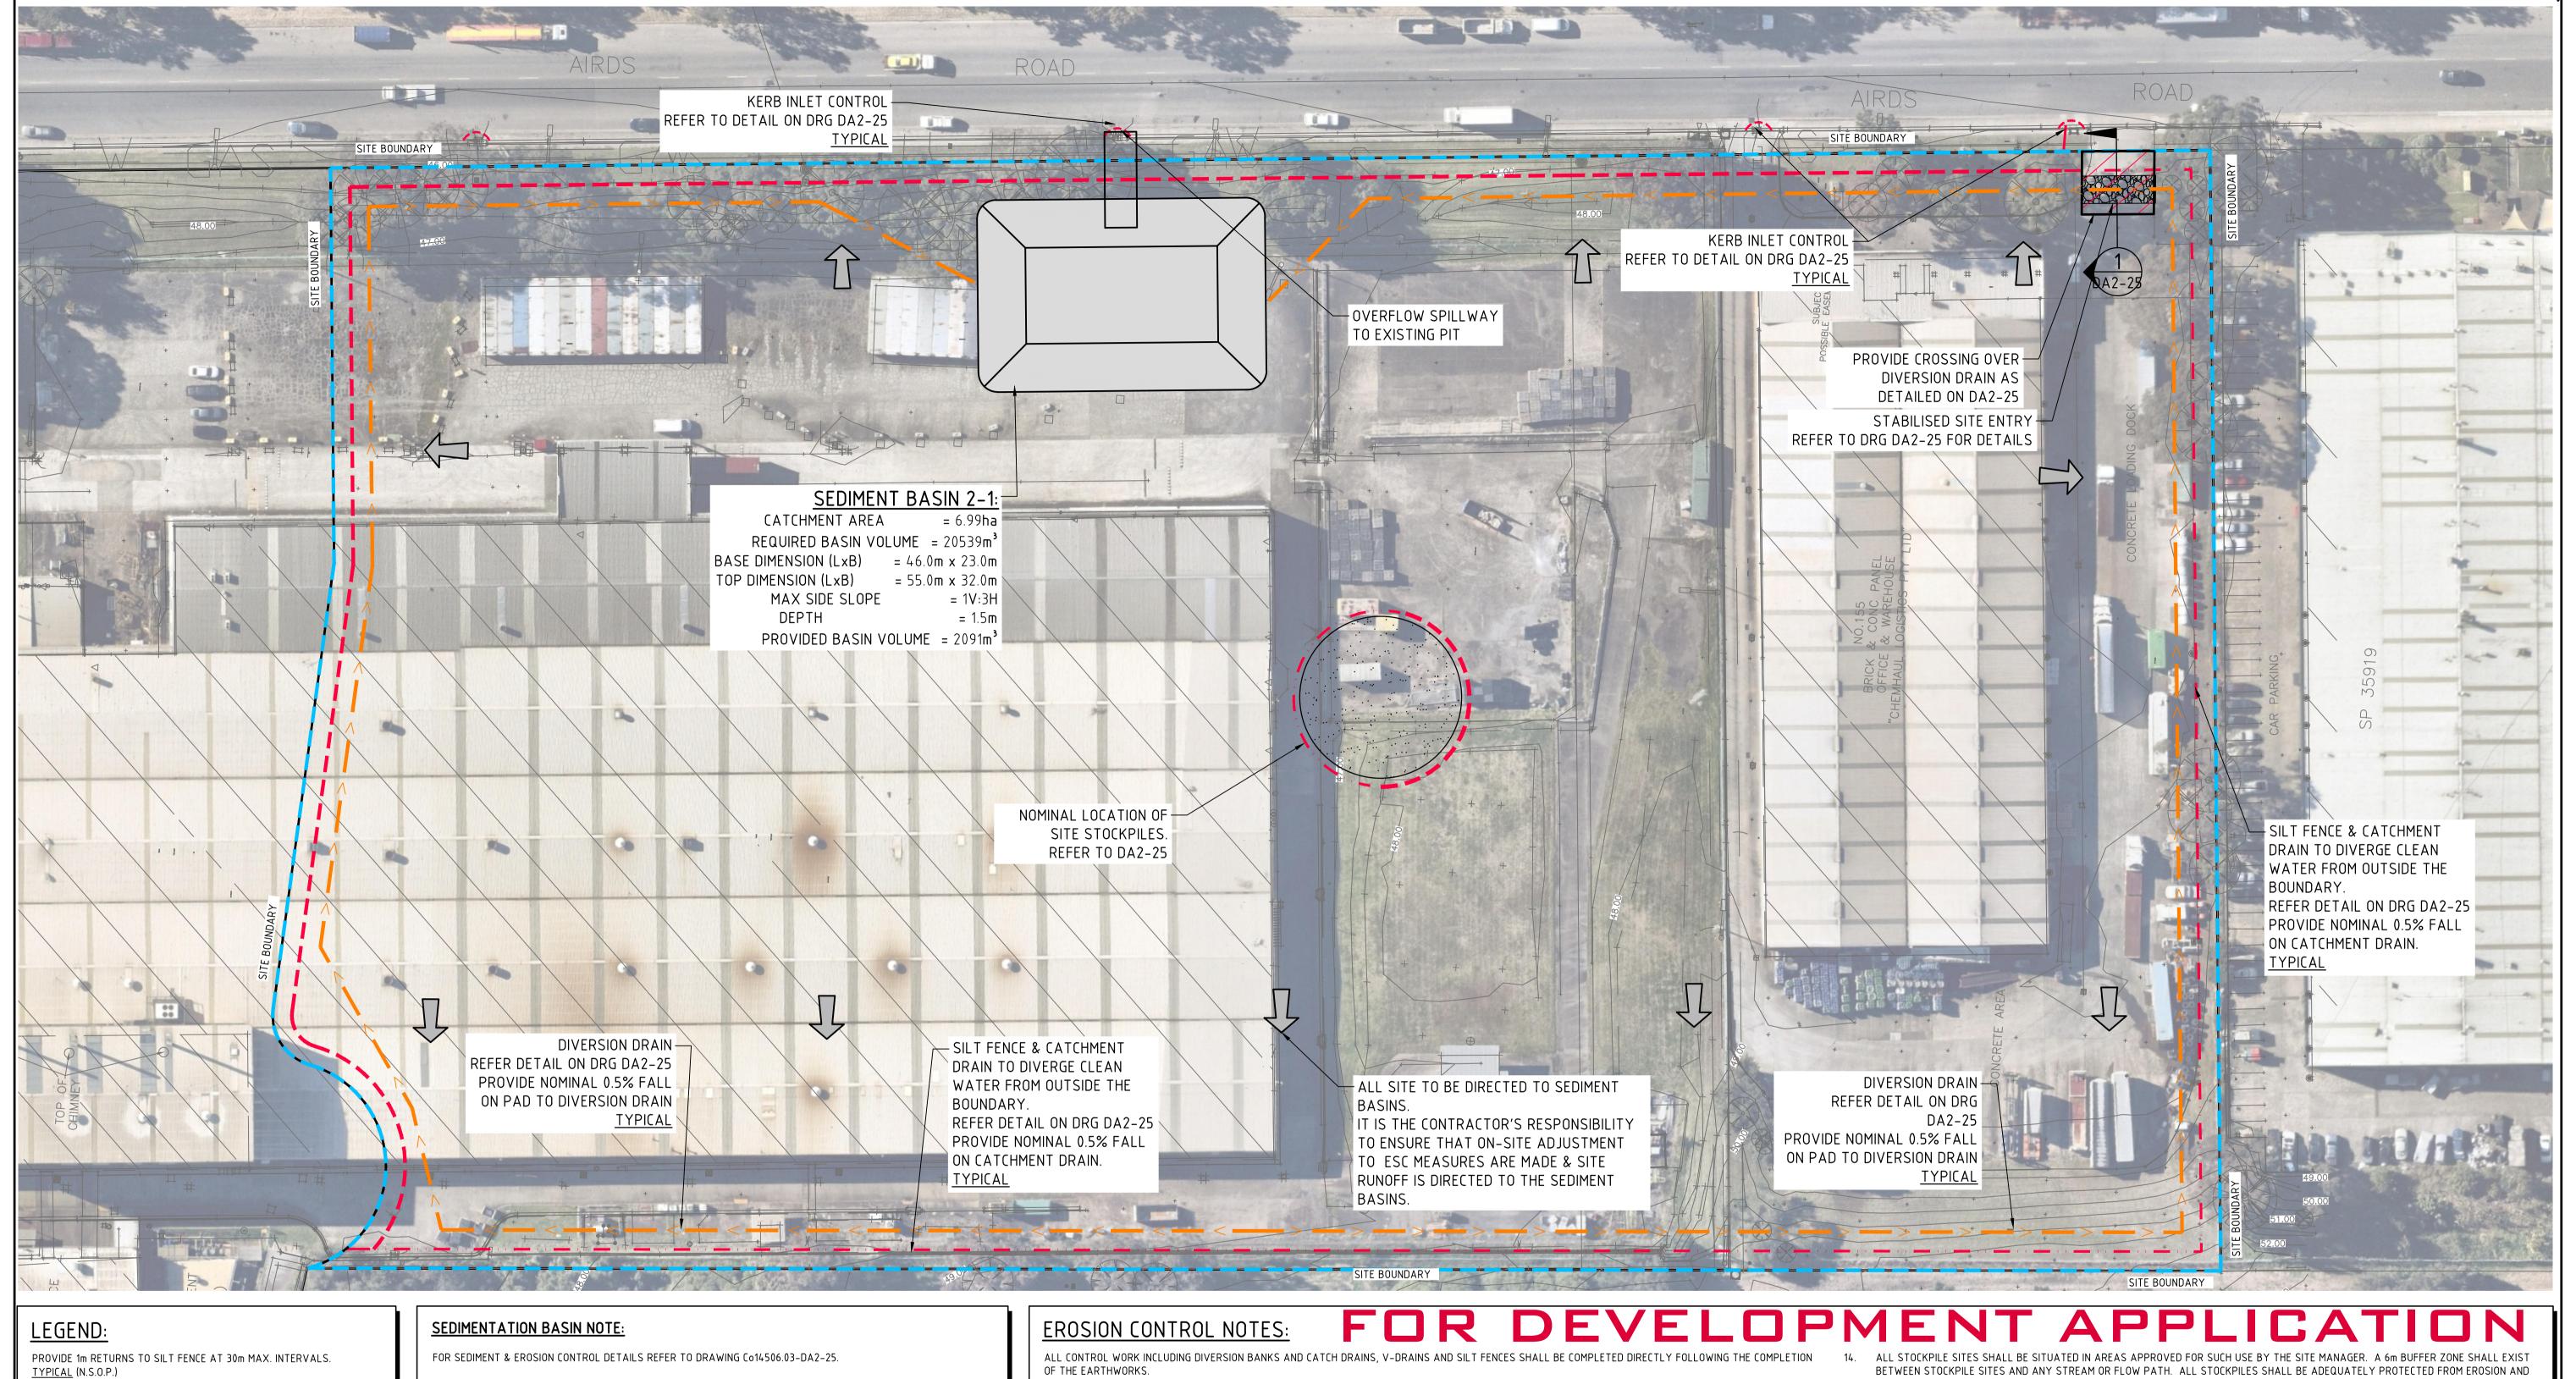

- DEN

- DENOTES DIVERSION DRAIN

- DENOTES CATCHMENT BOUNDARY

- DENOTES SILT FENCE WITH CATCH DRAIN

- DENOTES SILT FENCE ONLY



AMENDMENTS

- DENOTES CONSTRUCTION ENTRY

- DENOTES OVERLAND FLOW PATH

SEDIMENTATION BASIN SIZING BASED ON RECOMMENDATIONS OF 'SOILS AND CONSTRUCTION, MANAGING URBAN STORMWATER-THE BLUE BOOK'.

SEDIMENTATION BASIN SIZING BASED ON RECOMMENDATIONS OF 'SOILS AND CONSTRUCTION, MANAGING URBAN STORMWAER-THE BLUE BOOK'. CAPACITY BASED ON 5-DAY RAINFALL DEPTHS AT 85th PERCENTILE INTENSITY (30.6mm) IN THE CAMPBELLTOWN CATCHMENT AREA.

APPROXIMATE AREA OF DISTURBED SITE = 2.80Ha

SEDIMENTATION BASINS TO COLLECT RUN-OFF IN EXTREME RAINFALL EVENTS. COLLECTED RUN-OFF TO BE ASSESSED BY A QUALIFIED LABORATORY FOR DOUSING RATES OF ALUM OR GYPSUM TO ENSURE COAGULATION OF SEDIMENTS PRIOR TO WATER BEING DISCHARGED TO COUNCIL STORMWATER SYSTEM.

CLIENT

EACH BASIN IS TO HAVE A MARKER PLACED AS PER THE DETAIL TO INDICATE WHEN SEDIMENT IS TO BE REMOVED. REMOVED SEDIMENT IS TO BE CLASSED AND DEWATERED PRIOR TO REMOVAL FROM SITE.

ALLOWANCE TO BE MADE DURING BENCHING OF SITE TO ENSURE RUN-OFF IS DIRECTED TO SEDIMENTATION BASINS.

#### NOTES:

DATE

ISSUE

- ASSUME TYPE D SOIL (CLAY/SILTY CLAY)
   ASSUME GROUP D SOIL (HIGH PLASTICITY AND SHRINK/SWELL PROPERTIES)
- 3. Cv = 0.64 & LENGTH TO WIDTH RATIO OF 2 (MIN.)
  SOIL TYPE TO BE ASSESSED BY A GEOTECHNICAL ENGINEER

OF THE EARTHWORKS.

- 1. SILT FENCES AND SILT FENCE RETURNS SHALL BE ERECTED CONVEX TO THE CONTOUR TO POND WATER.
  2. HAY BALE BARRIERS AND GEOFABRIC FENCES ARE TO BE CONSTRUCTED TO TOE OF BATTER, PRIOR TO COMMENCEMENT OF EARTHWORKS,
- IMMEDIATELY AFTER CLEARING OF VEGETATION AND BEFORE REMOVAL OF TOP SOIL.

  3. ALL TEMPORARY EARTH BERMS. DIVERSION AND SILT DAM EMBANKMENTS ARE TO BE MACHINE COMPACTED, SEEDED AND MULCHED FOR
- TEMPORARY VEGETATION COVER AS SOON AS THEY HAVE BEEN FORMED.
  4. CLEAR WATER IS TO BE DIVERTED AWAY FROM DISTURBED GROUND AND INTO THE DRAINAGE SYSTEM.
- 5. THE CONTRACTOR IS RESPONSIBLE FOR MAINTAINING AND PROVIDING ON GOING ADJUSTMENT TO EROSION CONTROL MEASURES AS REQUIRED DURING CONSTRUCTION.
- 6. ALL SEDIMENT TRAPPING STRUCTURES AND DEVICES ARE TO BE INSPECTED AFTER STORMS FOR STRUCTURAL DAMAGE OR CLOGGING, TRAPPED MATERIAL IS TO BE REMOVED TO A SAFE, APPROVED LOCATION.
- 7. ALL FINAL EROSION PREVENTION MEASURES INCLUDING THE ESTABLISHMENT OF GRASSING ARE TO BE MAINTAINED UNTIL THE END OF THE DEFECTS LIABILITY PERIOD.
- 8. ALL EARTHWORKS AREAS SHALL BE ROLLED ON A REGULAR BASIS TO SEAL THE EARTHWORKS.
  9. ALL FILL AREAS ARE TO BE LEFT WITH A BUND AT THE TOP OF THE SLOPE AT THE END OF EACH DAYS EARTHWORKS. THE HEIGHT OF THE
- BUND SHALL BE A MINIMUM OF 200mm.

  10 ALL CUT AND FILL SLOPES ARE TO BE SEEDED AND HYDROMULCHED WITHIN 10 DAYS OF COMPLETION OF FORMATION.
- 10. ALL CUT AND FILL SLOPES ARE TO BE SEEDED AND HYDROMULCHED WITHIN 10 DAYS OF COMPLETION OF FORMATION.

  11. AFTER REVEGETATION OF THE SITE IS COMPLETE AND THE SITE IS STABLE IN THE OPINION OF A SUITABLY QUALIFIED PERSON ALL
- 12. ALL TOPSOIL STOCKPILES ARE TO BE SUITABLY COVERED TO THE SATISFACTION OF THE SITE MANAGER TO PREVENT WIND AND WATER
- EROSION.

  ANY AREA THAT IS NOT APPROVED BY THE CONTRACT ADMINISTRATOR FOR CLEARING OR DISTURBANCE BY THE CONTRACTOR'S ACTIVITIES SHALL BE CLEARLY MARKED AND SIGN POSTED, FENCED OFF OR OTHERWISE APPROPRIATELY PROTECTED AGAINST ANY SUCH DISTURBANCE

- CONTAMINATION OF THE SURROUNDING AREA BY USE OF THE MEASURES APPROVED IN THE EROSION AND SEDIMENTATION CONTROL PLAN.

  ACCESS AND EXIT AREAS SHALL INCLUDE SHAKE-DOWN OR OTHER METHODS APPROVED BY THE SITE MANAGER FOR THE REMOVAL OF SOIL MATERIALS FORM MOTOR VEHICLES.
- THE CONTRACTOR IS TO ENSURE RUNOFF FROM ALL AREAS WHERE THE NATURAL SURFACE IS DISTURBED BY CONSTRUCTION, INCLUDING ACCESS ROADS, DEPOT AND STOCKPILE SITES, SHALL BE FREE OF POLLUTANTS BEFORE IT IS EITHER DISPERSED TO STABLE AREAS OR DIRECTED TO NATURAL WATERCOURSES.
- 7. THE CONTRACTOR SHALL PROVIDE AND MAINTAIN SLOPES, CROWNS AND DRAINS ON ALL EXCAVATIONS AND EMBANKMENTS TO ENSURE SATISFACTORY DRAINAGE AT ALL TIMES WATER SHALL NOT BE ALLOWED TO POND ON THE WORKS UNLESS SUCH PONDING IS PART OF AN APPROVED ESCP / SWMP.



#### **EROSION & SEDIMENT CONTROL PLAN**

SCALE 1:500

5m 0 10 20 30 40 50п

SCALE 1:500 AT A1 SIZE SHEET

TALE 1:500 AT A1 SIZE SHEET

ISSUED FOR DEVELOPMENT APPLICATION

ISSUED FOR INFORMATION

02.03.23

05.09.22

A






PROPOSED WAREHOUSE DEVELOPMENT
149-155 AIRDS ROAD, MINTO
NSW, 2566

TEMPORARY WORK SUCH AS SILT FENCE, DIVERSION DRAINS ETC SHALL BE REMOVED.

DESIGNED DRAWN DATE CHECKED SIZE SCALE CAD REF:

IL IL AUG '22 DS A1 AS SHOWN C014521.01-DA 2-2

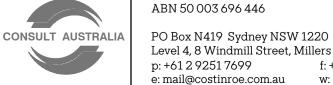

Costin Roe Consulting Pty Ltd.

PO Box N419 Sydney NSW 1220
Level 4, 8 Windmill Street, Millers Point NSW 2000
p: +61 2 9251 7699 f: +61 2 9241 3731
e: mail@costinroe.com.au w: costinroe.com.au

CONSULT


CIVIL &
STRUCTURAL
ENGINEERS


EROSION & SEDIMENT CONTROL PLAN

DRAWING TITLE

CO14521.01-DA2-20




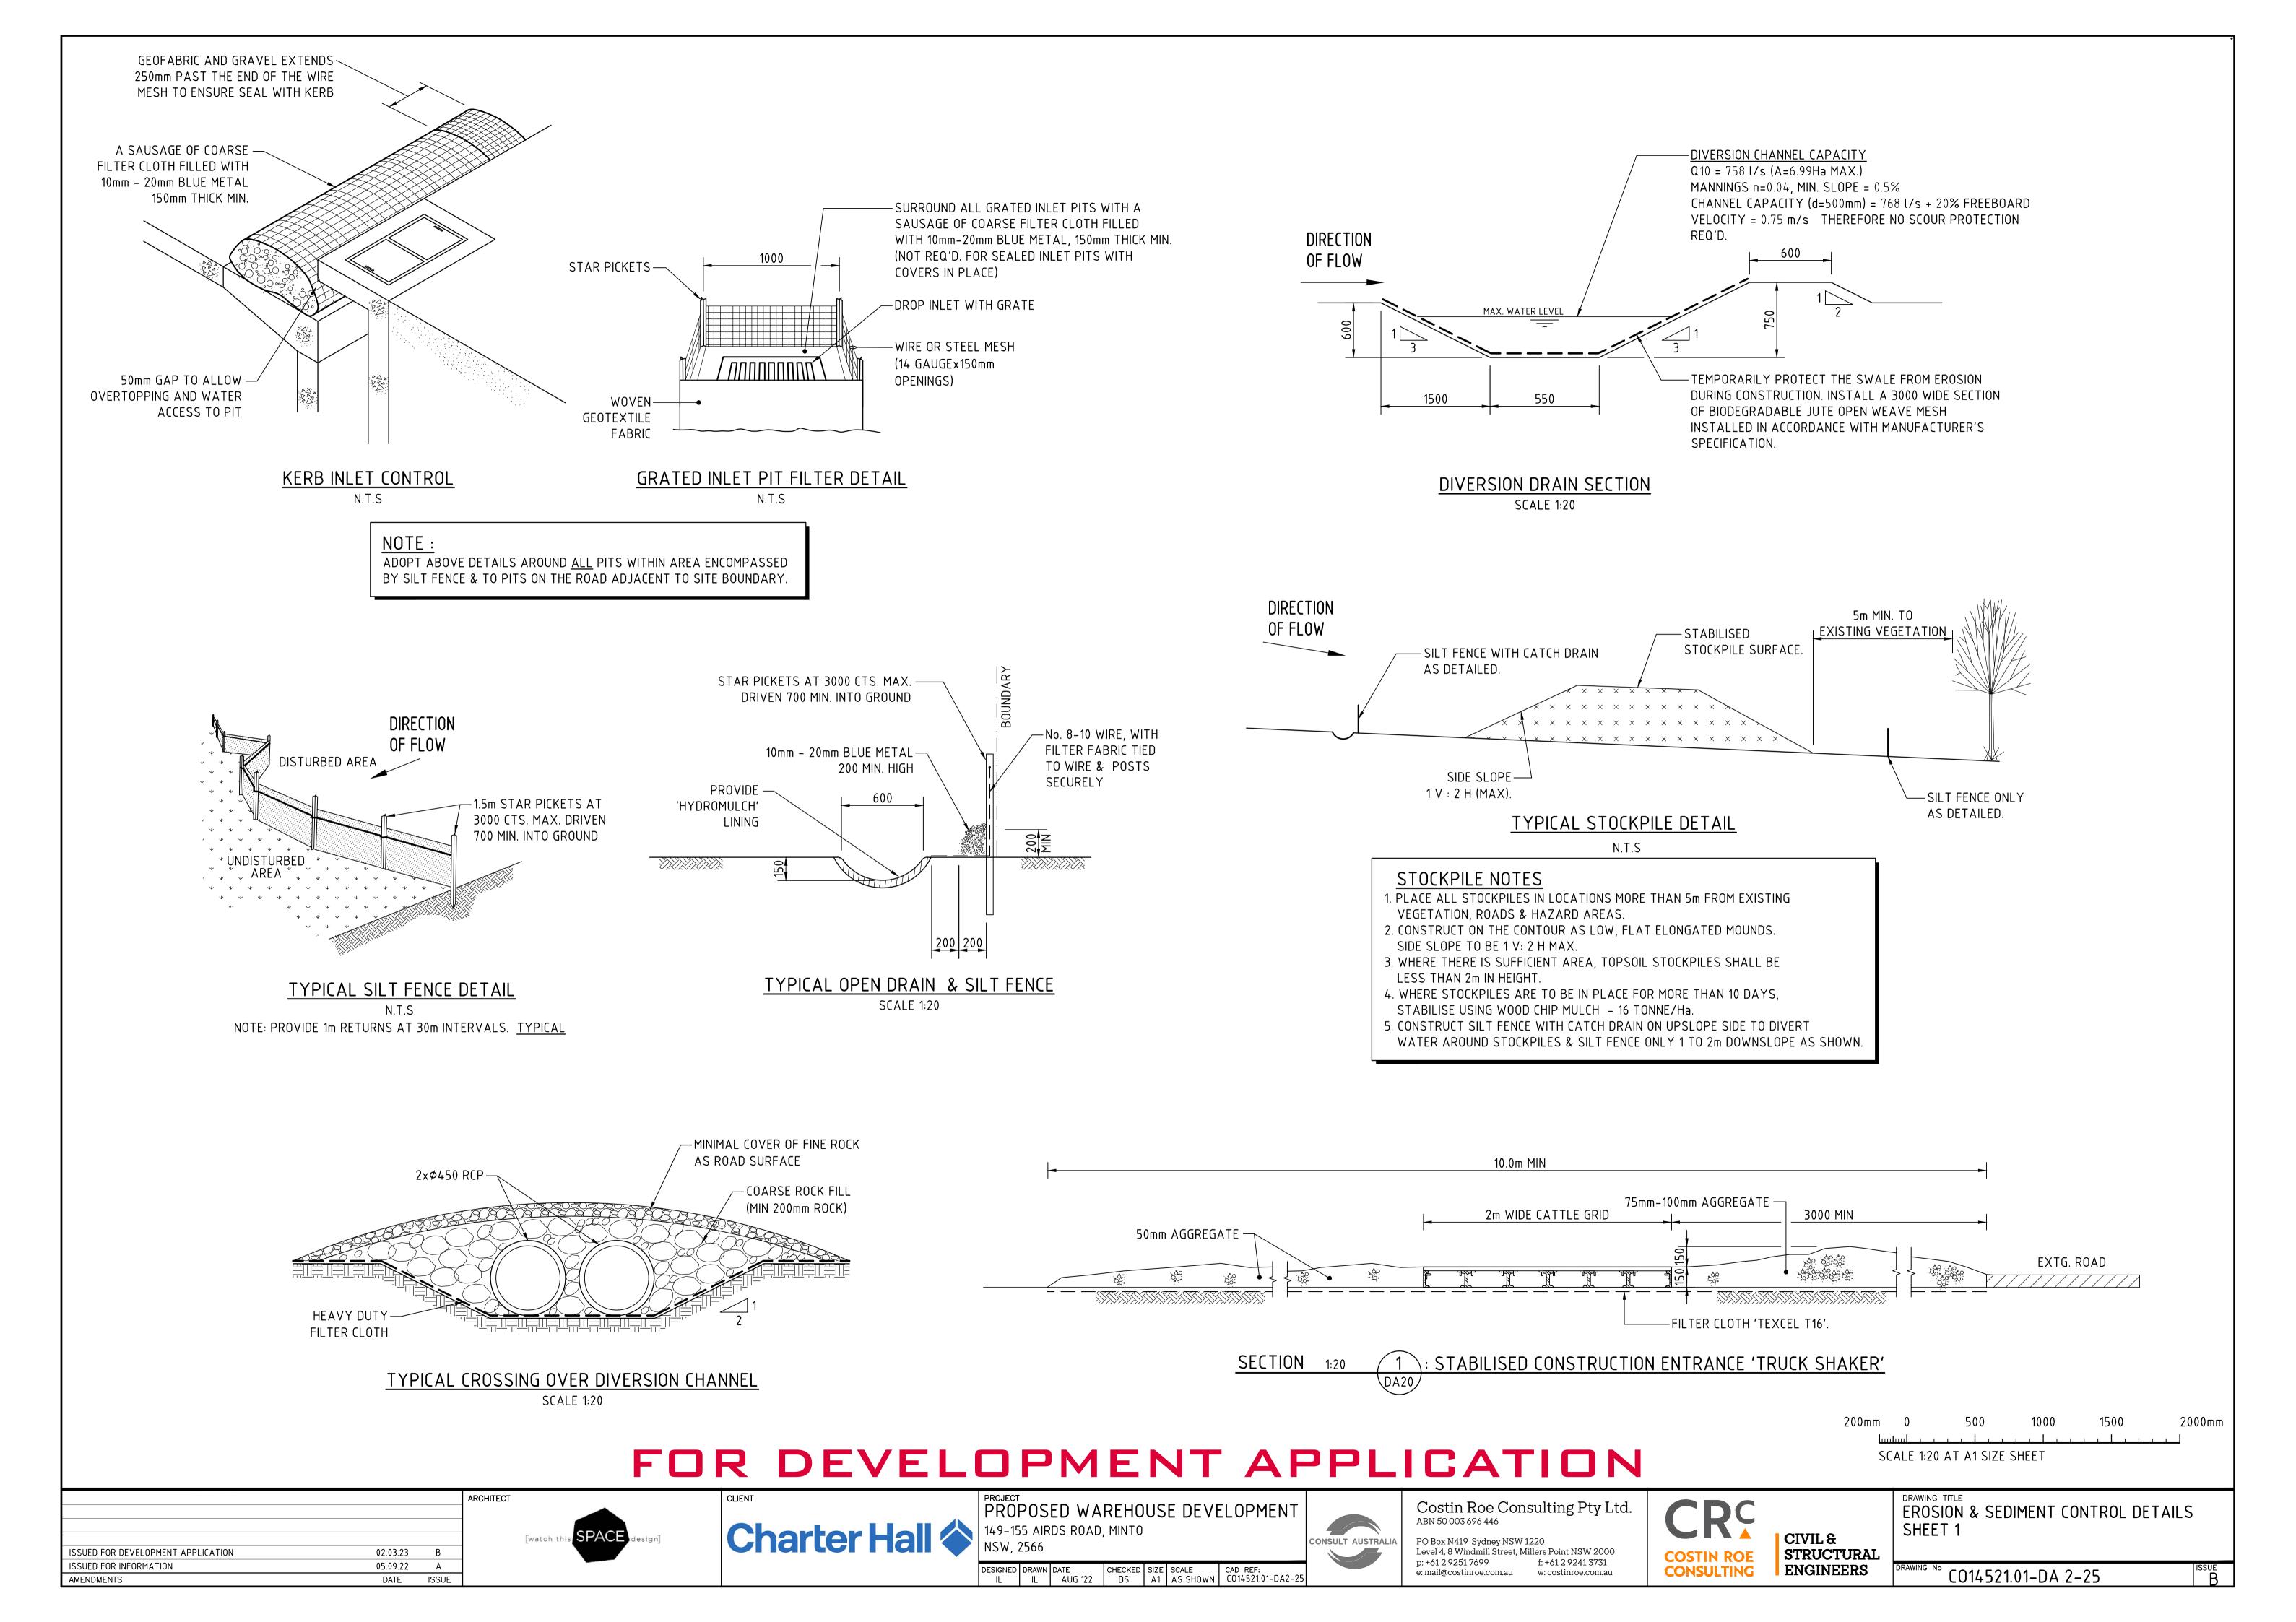

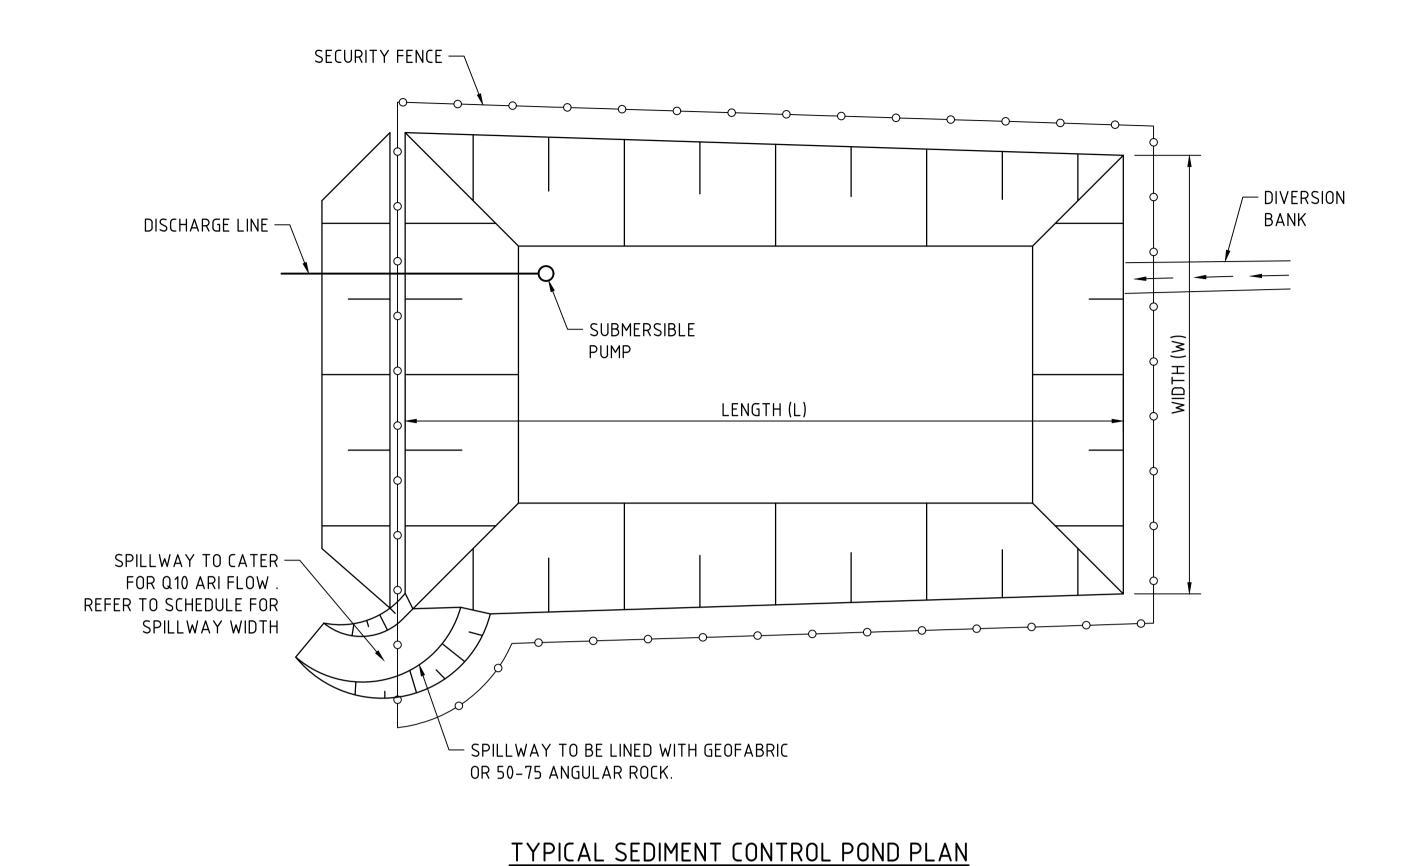


SCALE 1:250

SPILLWAY SCHEDULE						
CATCHMENT	FLOW	WIDTH	FLOW DEPTH	ROCK SIZE	BUND HEIGHT ABOVE	
(Ha)	(m³/s)	(m)	(m)	(mm)	SPILLWAY (m)	
1	0.3	2	0.20	200	0.70	
2	0.6	4	0.20	200	0.70	
5	1.4	5	0.30	200	0.80	
10	2.8	8	0.35	200	0.85	

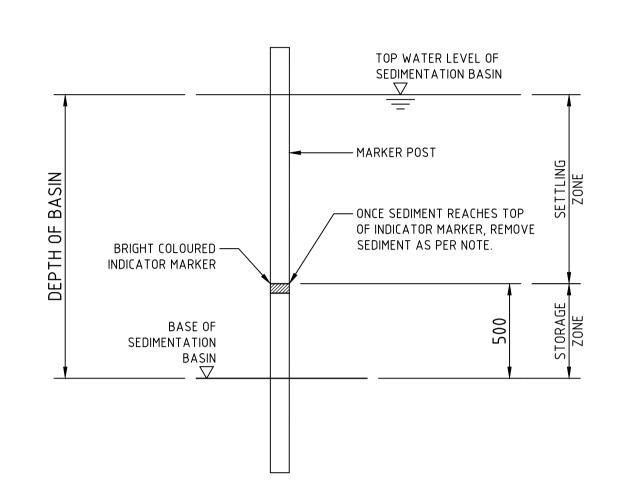

SEDIMENT STORAGE MARKER SCALE 1:20

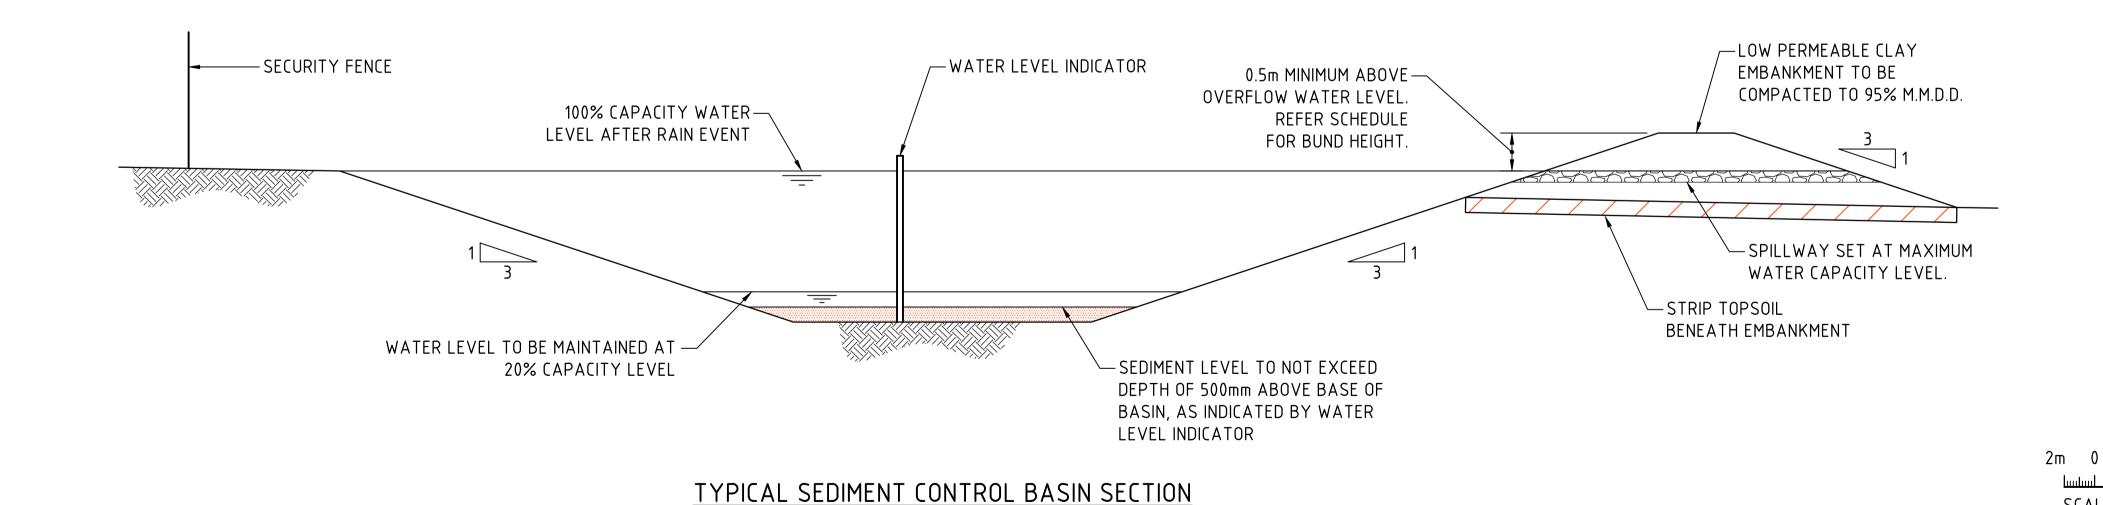

# FOR DEVELOPMENT APPLICATION

ARROHHIEDOT ISSUED FOR DEVELOPMENT APPLICATION 02.03.23 B ISSUED FOR INFORMATION 05.09.22 A AMENDMENTS DATE ISSUE





PROPOSED WAREHOUSE DEVELOPMENT 149-155 AIRDS ROAD, MINTO DESIGNED DRAWN DATE CHECKED SIZE SCALE CAD REF:
L IL AUG '22 DS A1 AS SHOWN C014521.01-DA2-26

SCALE 1:50



Costin Roe Consulting Pty Ltd.
ABN 50 003 696 446

PO Box N419 Sydney NSW 1220 Level 4, 8 Windmill Street, Millers Point NSW 2000 f: +61 2 9241 3731 p: +61 2 9251 7699 e: mail@costinroe.com.au w: costinroe.com.au



CIVIL & STRUCTURAL **ENGINEERS** 

DRAWING TITLE **EROSION & SEDIMENT CONTROL DETAILS** SHEET 2


2000mm


SCALE 1:250 AT A1 SIZE SHEET


SCALE 1:50 AT A1 SIZE SHEET


SCALE 1:20 AT A1 SIZE SHEET

DRAWING No CO14521.01-DA 2-26

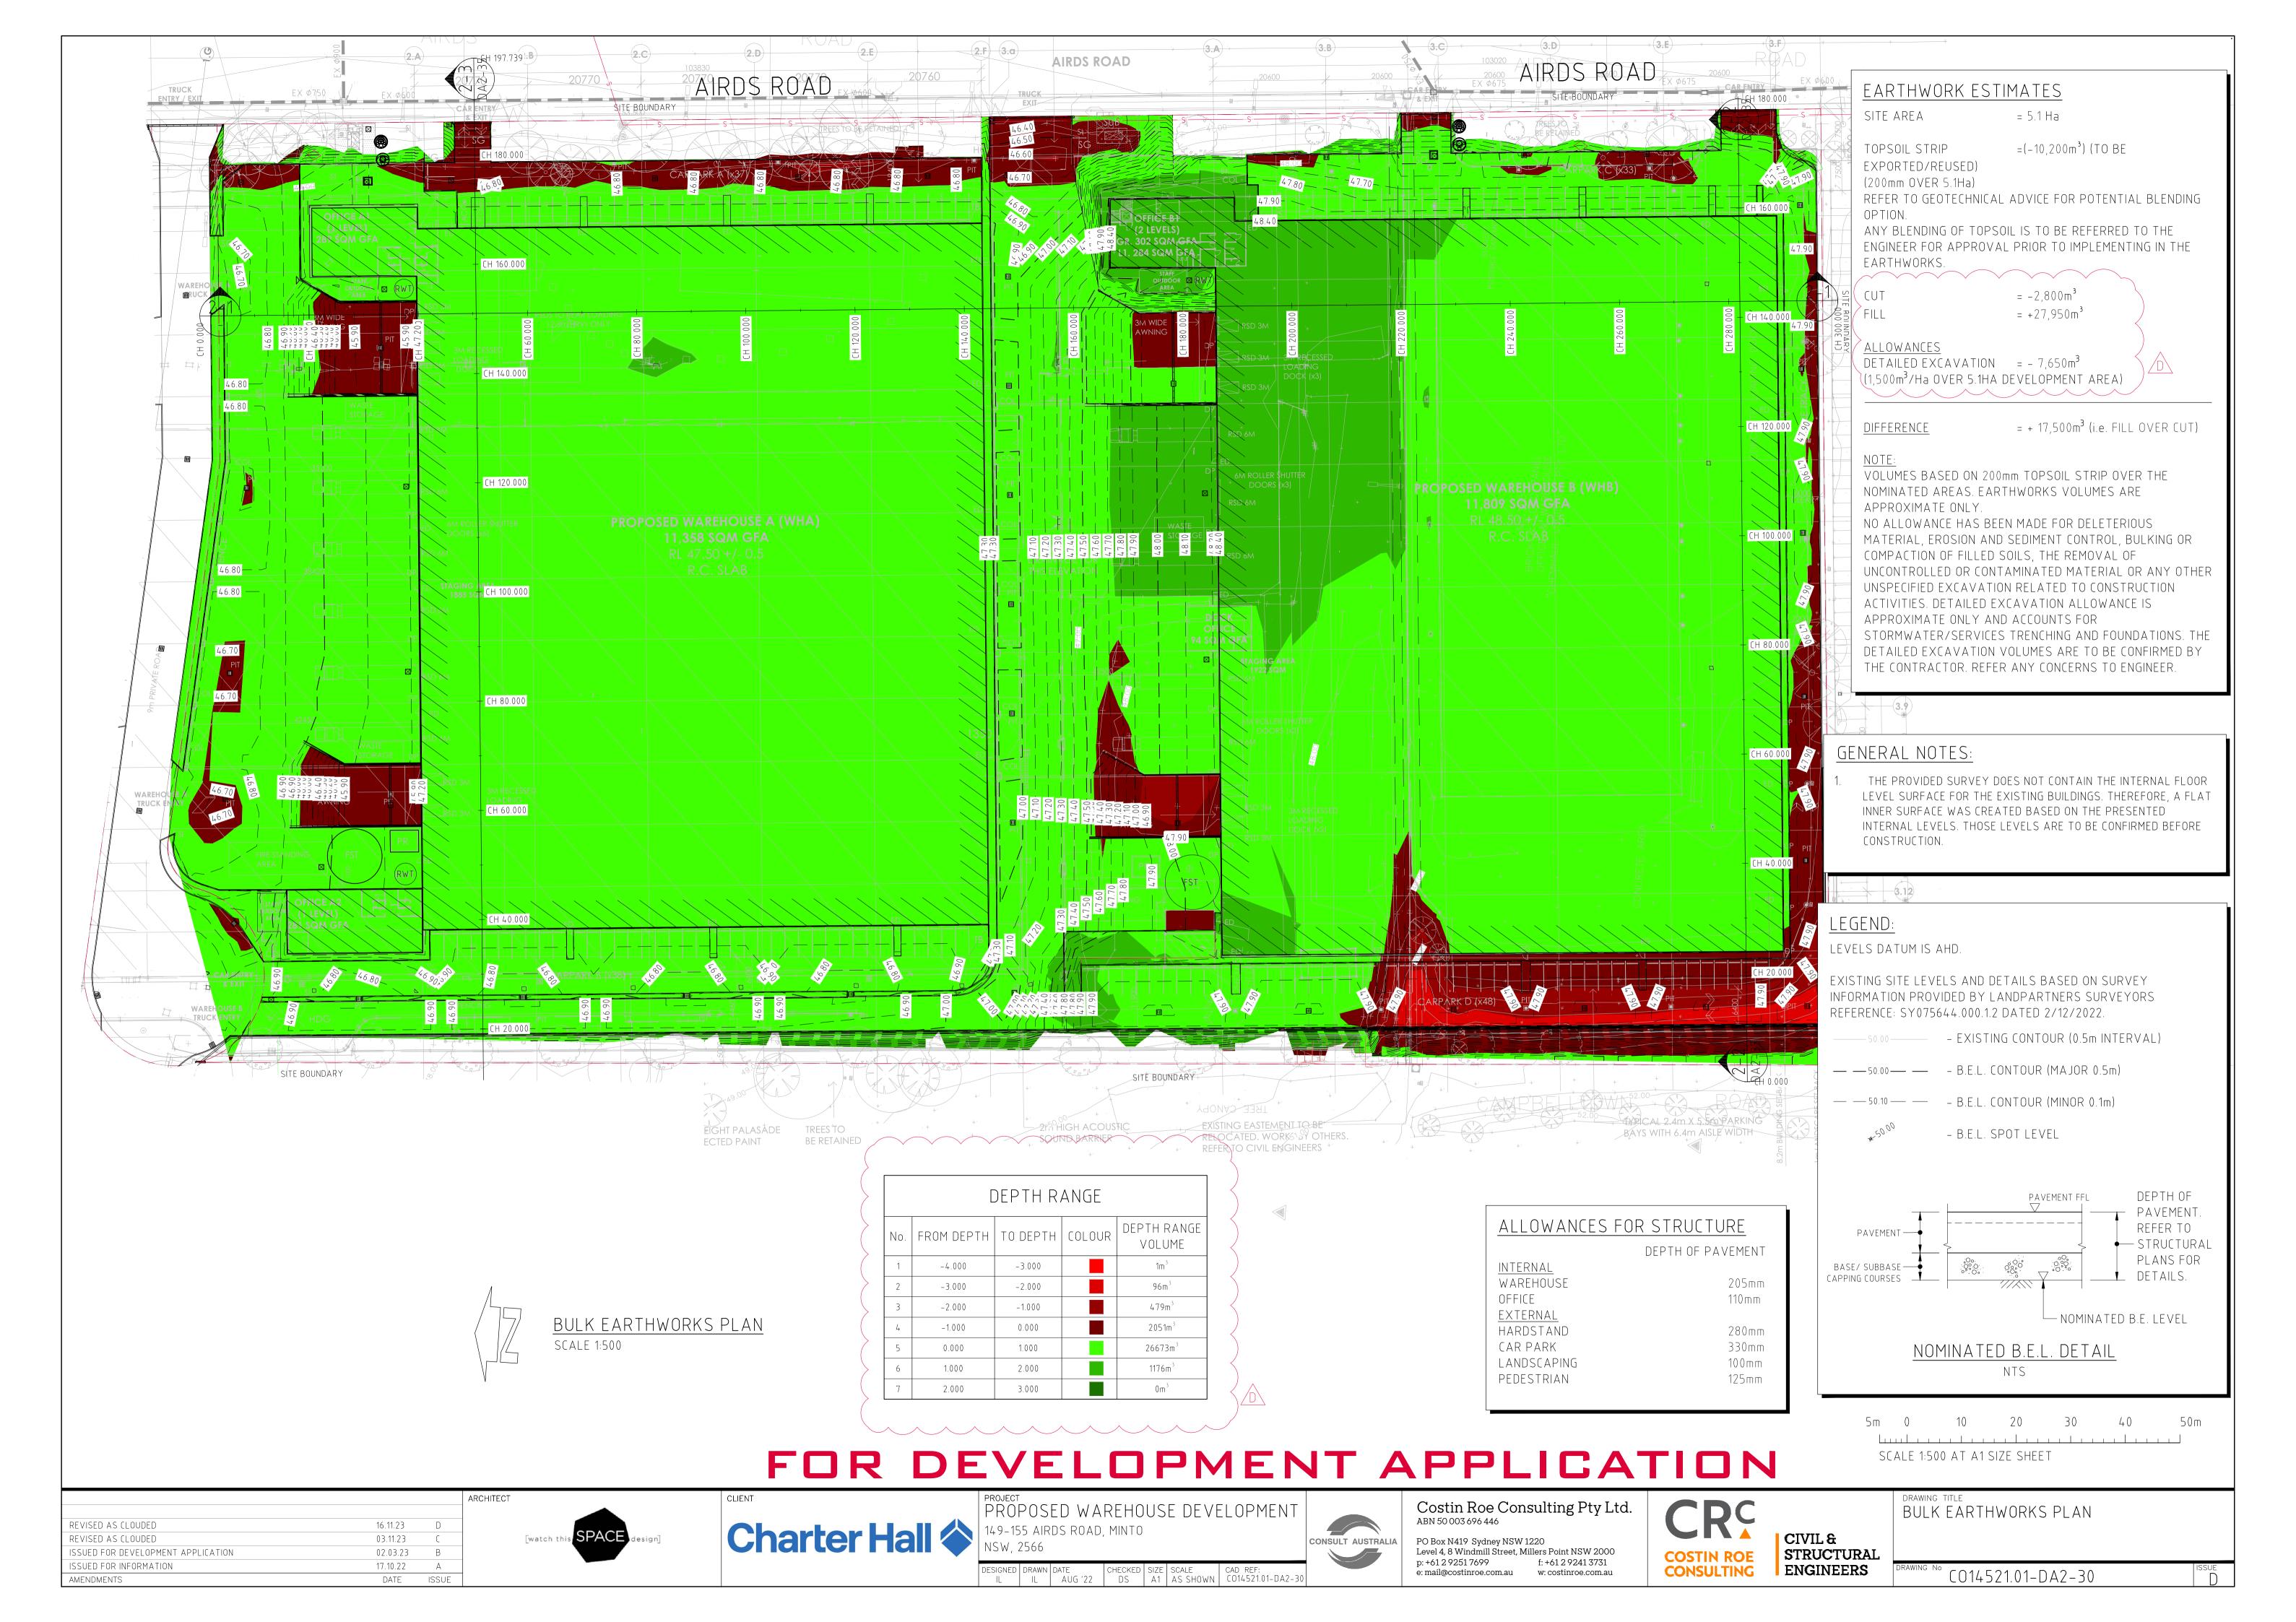


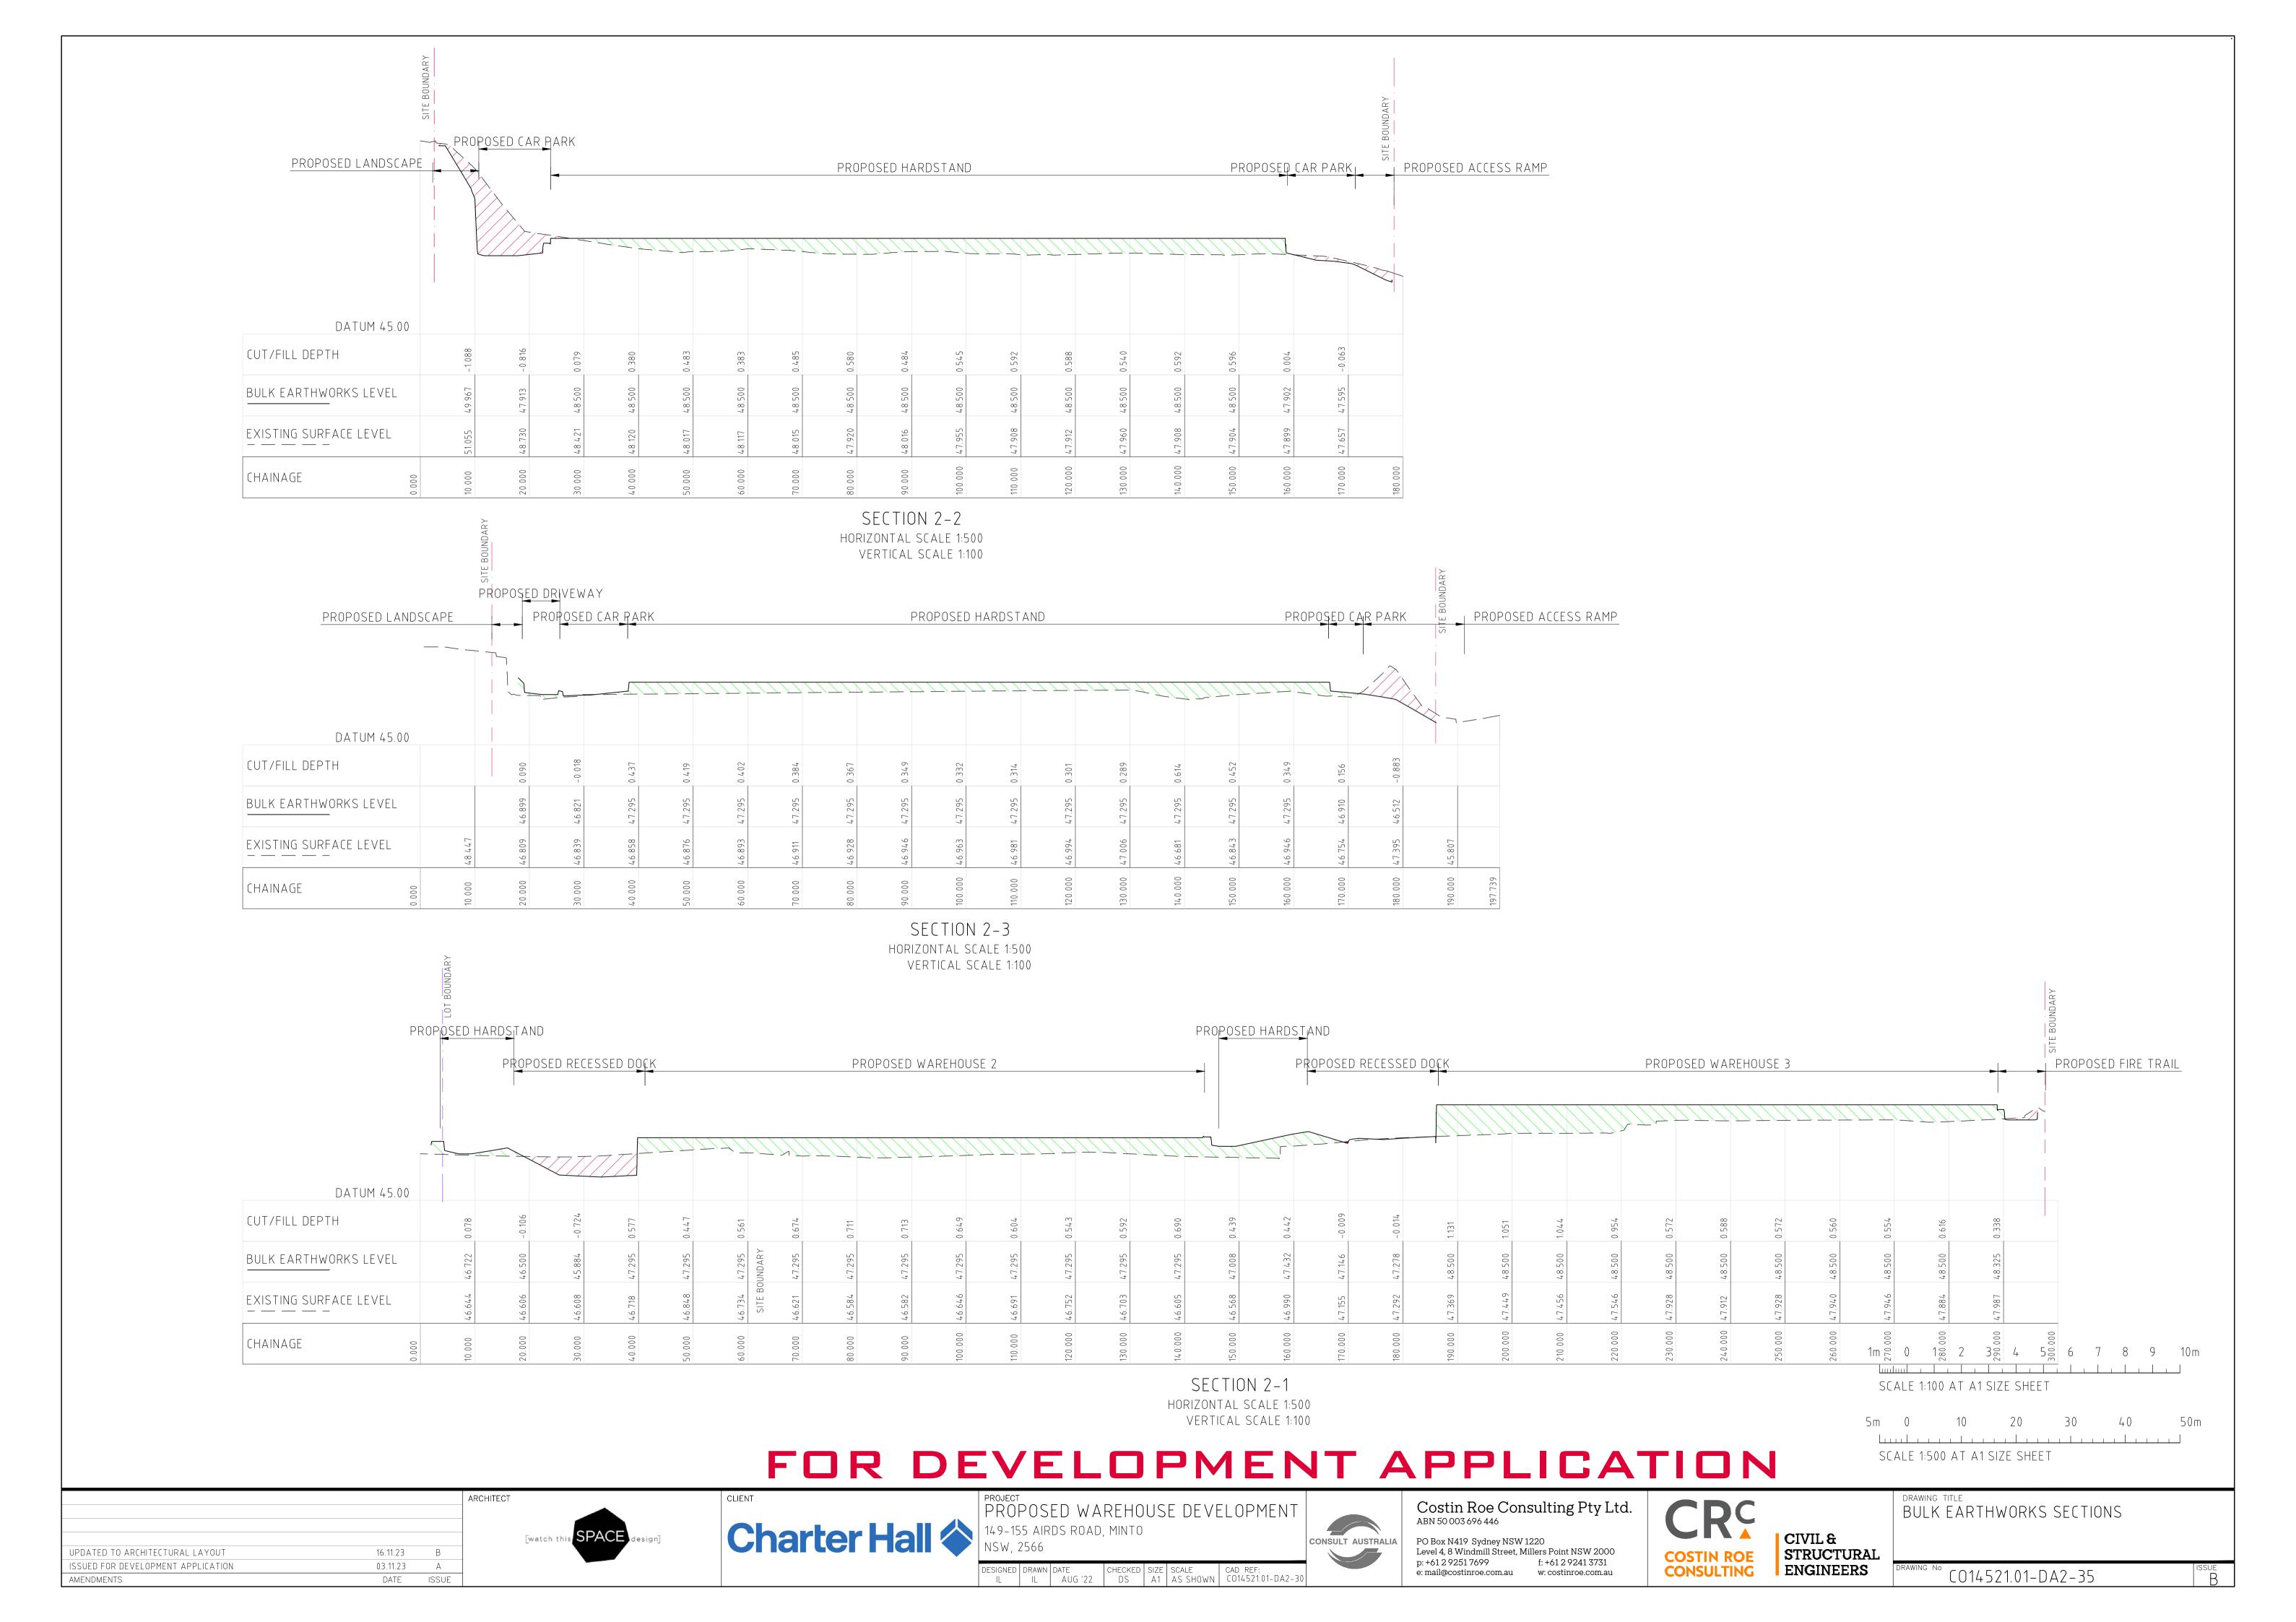

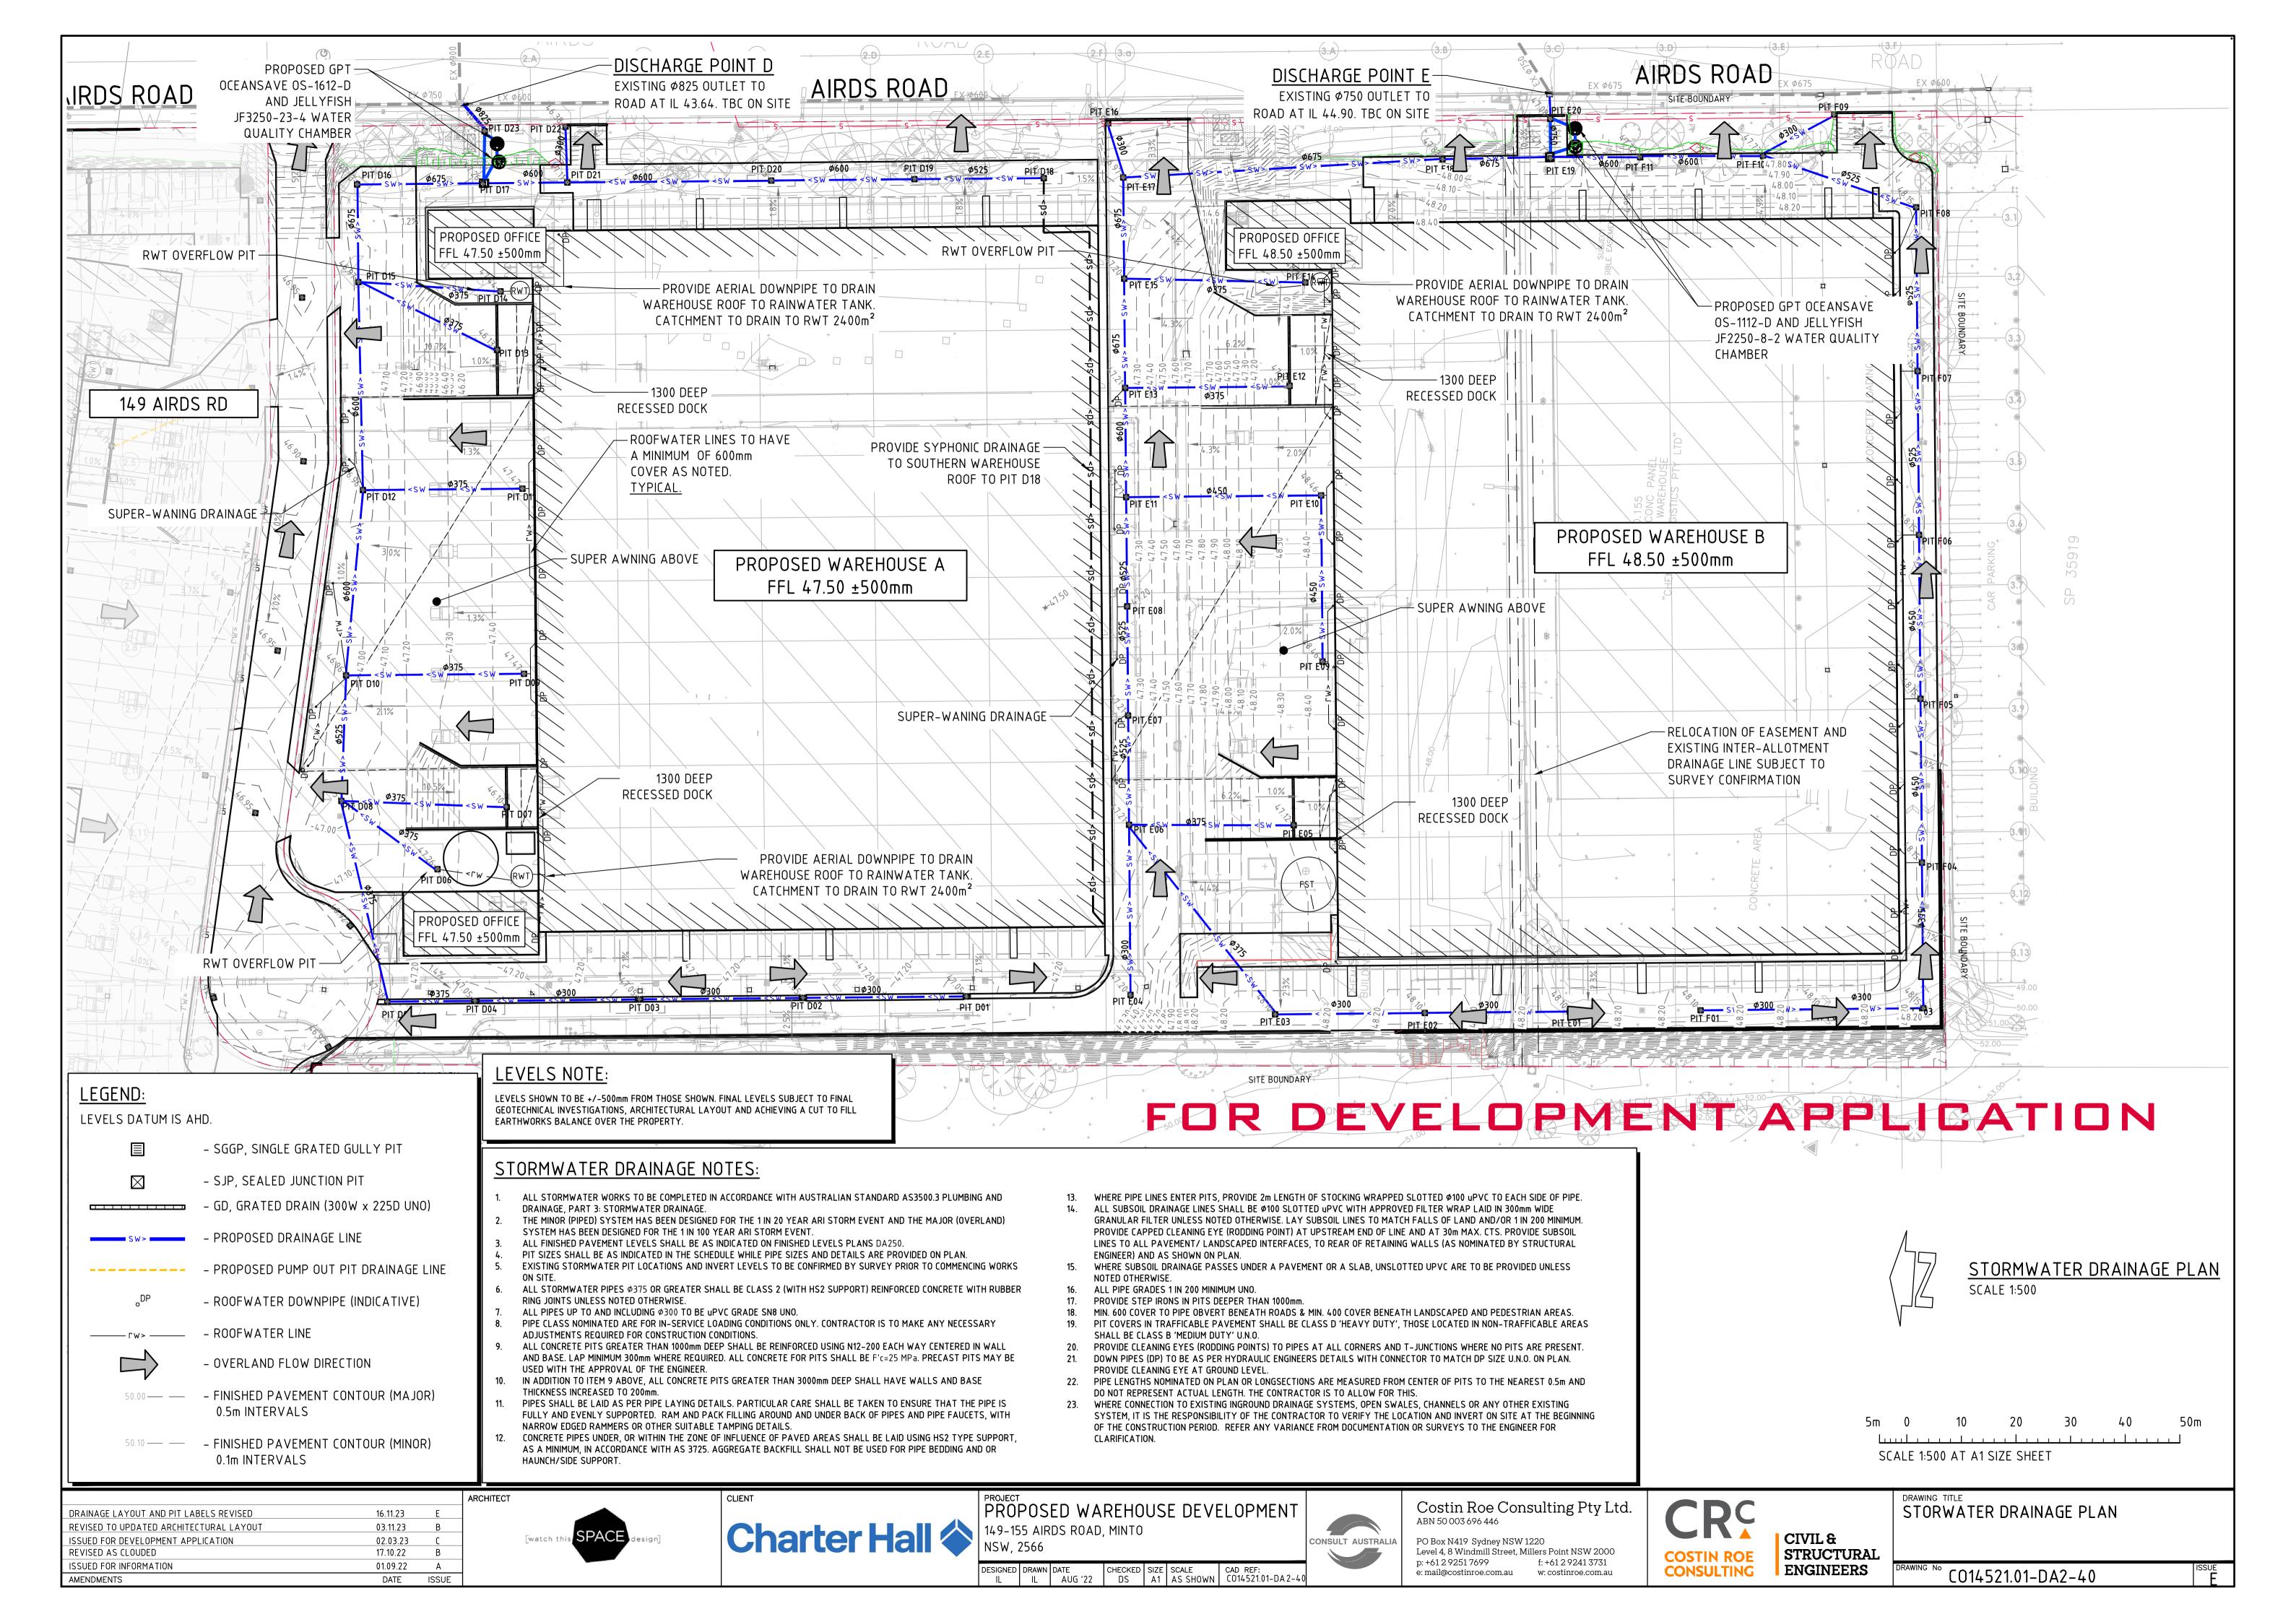

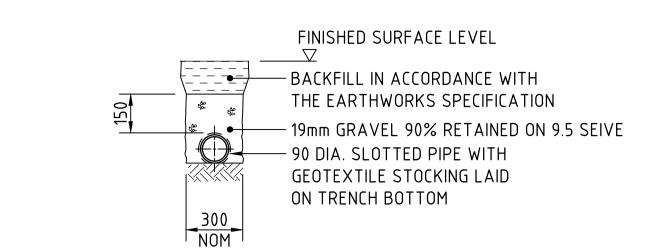



SUPPORT TO AGRICULTURAL DRAIN SCALE 1:20

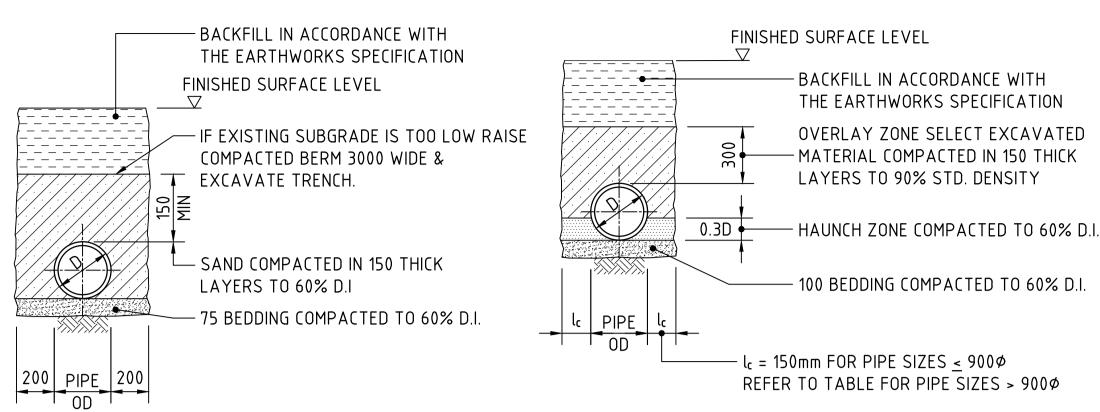

SUPPORT TO uPVC PIPES SCALE 1:20

TYPE H1 SUPPORT TO CONCRETE PIPES AT LANDSCAPED AREAS SCALE 1:20

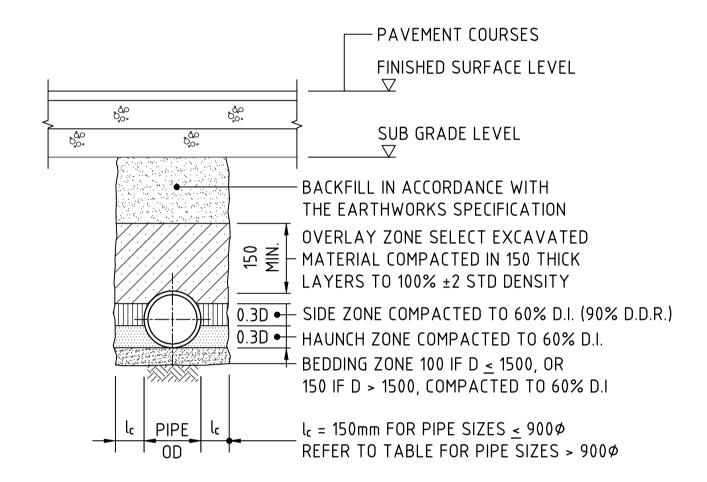

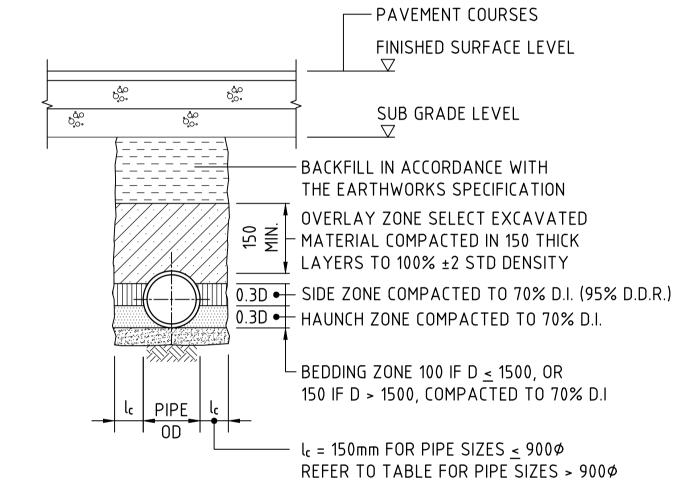

SCALE 1:20

D < 1050, MAX FILL = 6.0m

D > 1050, MAX FILL = 4.8m

#### TYPE HS2 SUPPORT TO CONCRETE PIPES UNDER PAVEMENT


TYPE HS3 SUPPORT TO CONCRETE PIPES UNDER PAVEMENT

SCALE 1:20 D < 1350, MAX FILL = 4.0m D > 1350, MAX FILL = 3.0m

BEDDING & HAUNCH MATERIAL GRADING				
SIEVE SIZE (mm)	WEIGHT PASSING (%)			
19.0	100			
2.36	100 TO 50			
0.60	90 TO 50			
0.30	60 TO 10			
0.15	25 TO 0			
0.075	10 TO 0			


SIDE ZONE WIDTH					
PIPE SIZE (mm)	I <sub>C</sub> (mm)				
<u>&lt;</u> 900∅	150				
1050ø	175				
1200¢	200				
1350¢	225				
1500¢	250				
1650ø	275				
1800¢	300				
ENGINEER TO SPECIFY TRENCH					
WIDTHS FOR PIPE SIZES					
GREATER THAN 1800♥					

SIDE ZONE MATERIAL GRADING				
SIEVE SIZE (mm)	WEIGHT PASSING (%)			
19.0	100			
9.5	100 TO 50			
2.6	100 TO 30			
0.60	50 TO 15			
0.075	25 TO 0			
SELECT FILL MATERIAL IN ACCORDANCE WITH				
TABLE 1 AS 3725				

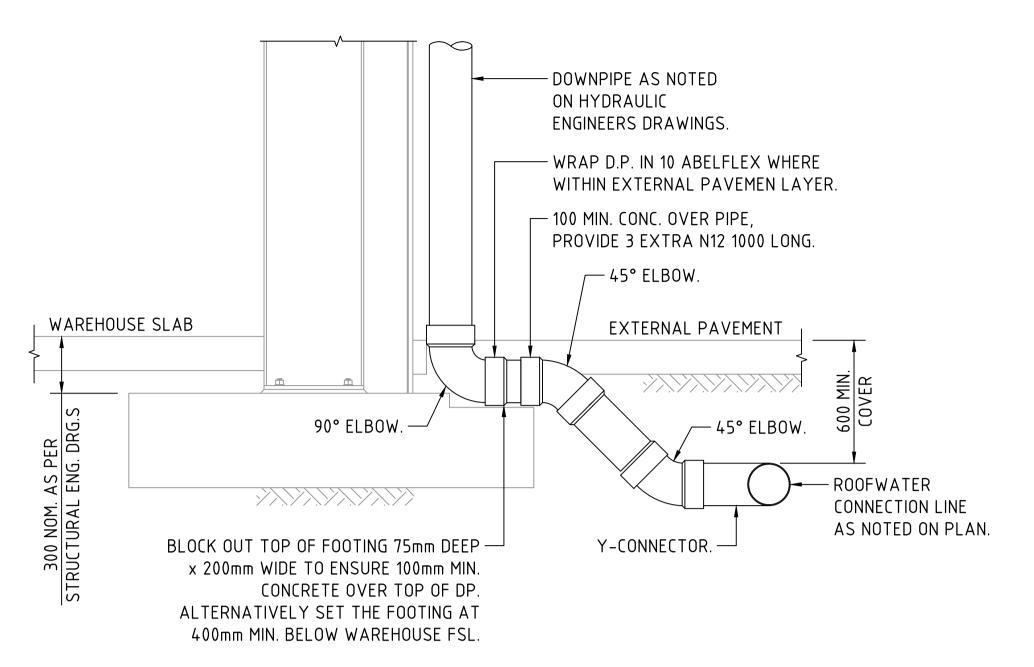

### DOWNPIPE TURN-UP DETAIL A

(AT FOOTING LOCATION) SCALE 1:20

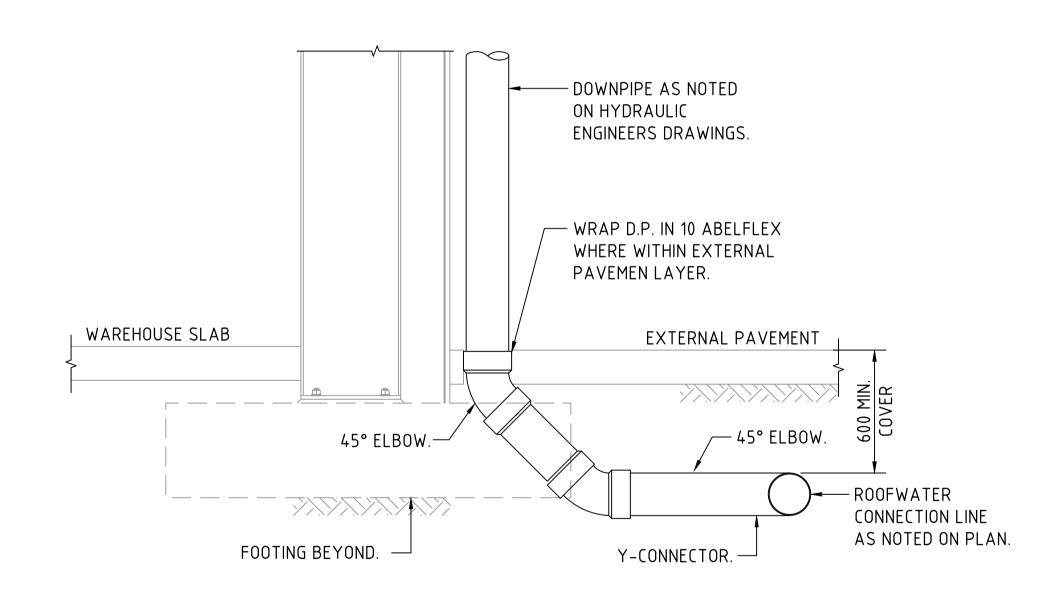

#### DOWNPIPE TURN-UP DETAIL B (CLEAR OF FOOTING) SCALE 1:20

# FOR DEVELOPMENT APPLICATION

2000mm SCALE 1:20 AT A1 SIZE SHEET

ARROHIEECT ISSUED FOR DEVELOPMENT APPLICATION 02.03.23 ISSUED FOR INFORMATION 01.09.22 DATE ISSUE AMENDMENTS



PROPOSED WAREHOUSE DEVELOPMENT 149-155 AIRDS ROAD, MINTO



Costin Roe Consulting Pty Ltd. ABN 50 003 696 446

PO Box N419 Sydney NSW 1220 Level 4, 8 Windmill Street, Millers Point NSW 2000 f: +61 2 9241 3731 p: +61 2 9251 7699 e: mail@costinroe.com.au w: costinroe.com.au




CIVIL & STRUCTURAL

DRAWING TITLE STORMWATER DRAINAGE DETAILS SHEET 1

CO14521.01-DA 2-45

DESIGNED DRAWN DATE CHECKED SIZE SCALE CAD REF:
L IL AUG '22 DS A1 AS SHOWN C014521.01-DA2-45

**ENGINEERS** 

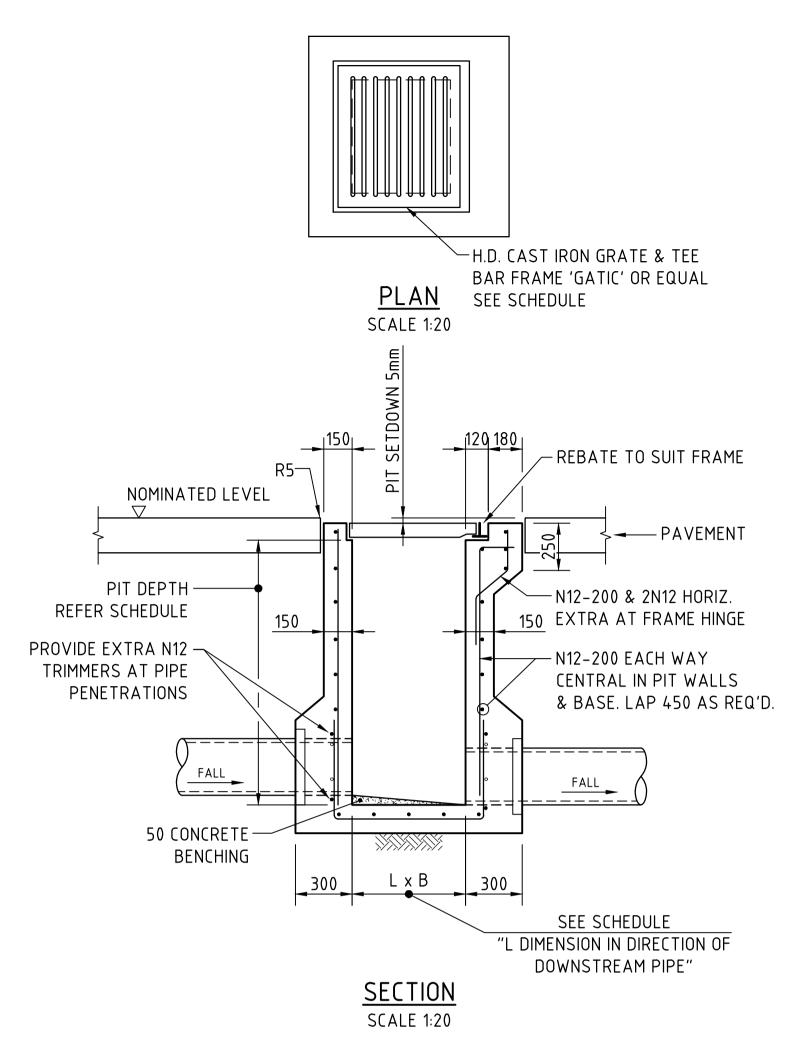

# -CONCRETE FILLED CAST IRON COVER & FRAME (GATIC OR EQUAL) SEE SCHEDULE <u>PLAN</u> SCALE 1:20 NOM REBATE TO SUIT FRAME 10 ISOLATION JOINT NOMINATED LEVEL - 2x100ø AG. DRAINS 2000 LONG AT UPSTREAM PIPES ONLY. TYPICAL ALL PIT TYPES N12-200 EACH WAY 300 LAP TO SPLICE AND AT CORNERS, 50 COVER FROM INSIDE FACE "L DIMENSION IN DIRECTION OF DOWNSTREAM PIPE"

**SECTION** 

SCALE 1:20

SEALED JUNCTION PIT - SJP

SJP/CIS & SGGP/CIS (CAST IN SLAB) PIT DETAIL GRATE/COVER SUPPORT CAST-INTO PAVEMENT SLAB (ADOPT IN CONCRETE PAVEMENTS FOR SGGP's & SJP's, WHERE


**SECTION** 

SCALE 1:20

NOMINATED LEVEL

JOINTS ARE NOT LOCATED WITHIN PROXIMITY OF THE GRATE)


### SINGLE GRATED GULLY PIT - SGGP

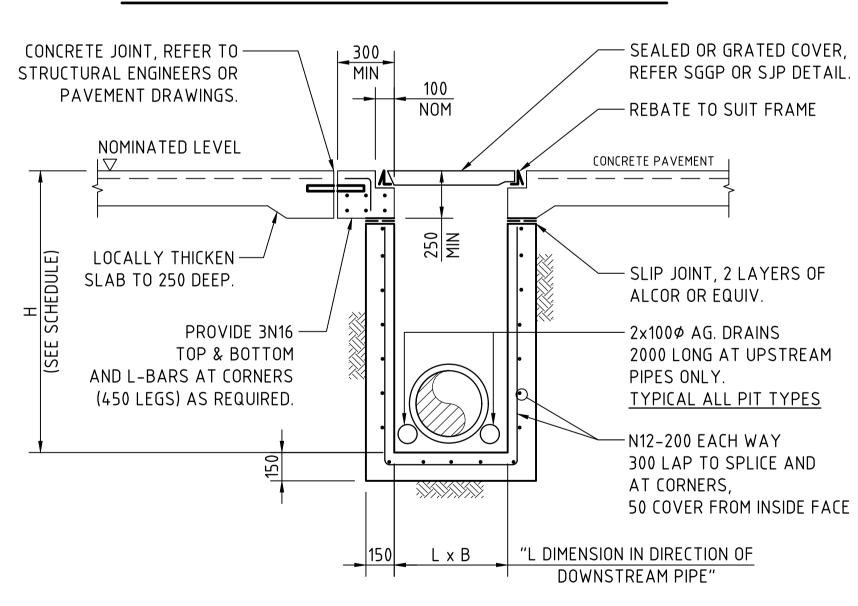

SCALE 1:20 SJP/CIS & SGGP/CIS (CAST IN SLAB) PIT DETAIL GRATE/COVER SUPPORT CAST-INTO PAVEMENT SLAB

**SECTION** 

(ADOPT IN CONCRETE PAVEMENT FOR SGGP's & SJP's, PANELS OR ADJACENT TO SLAB PANEL JOINTS)

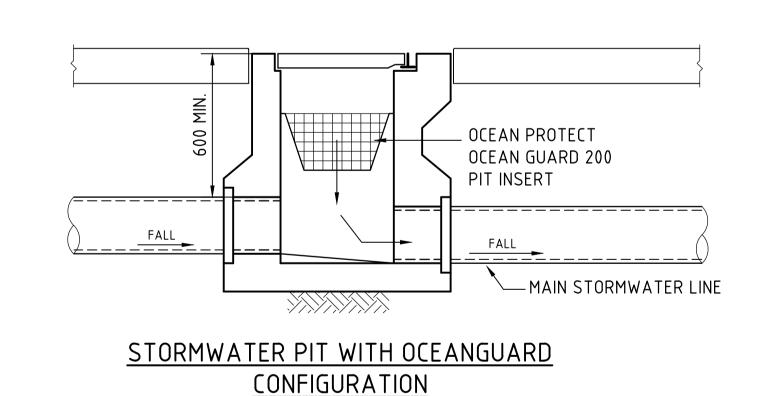

225ø/300ø OUTLET PIPE-

OCEAN PROTECT

PIT INSERT

OCEAN GUARD 200

GRATED DRAIN/STORMWATER PIT WITH OCEANGUARD CONFIGURATION SCALE 1:20

STORMWATER PIT

- SEALED OR GRATED COVER, REFER SGGP OR SJP DETAIL.

- REBATE TO SUIT FRAME

- SLIP JOINT, 2 LAYERS OF

2000 LONG AT UPSTREAM

TYPICAL ALL PIT TYPES

300 LAP TO SPLICE AND

50 COVER FROM INSIDE FACE

ALCOR OR EQUIV.

PIPES ONLY.

AT CORNERS,

"L DIMENSION IN DIRECTION OF

DOWNSTREAM PIPE"

- 2x100Ø AG. DRAINS

-N12-200 BOTH WAY

CONCRETE PAVEMENT

WHERE PITS ARE LOCATED IN THE CORNER OF SLAB FOR DEVELOPMENT APPLICATION

2000mm 200mm SCALE 1:20 AT A1 SIZE SHEET

WALL OF PIT BEHIND SHOWN DASHED

GRATED DRAIN

FALL TO PIT

ARROHIEECT ISSUED FOR DEVELOPMENT APPLICATION 02.03.23 ISSUED FOR INFORMATION 01.09.22 DATE ISSUE AMENDMENTS











PO Box N419 Sydney NSW 1220 Level 4, 8 Windmill Street, Millers Point NSW 2000 p: +61 2 9251 7699 f: +61 2 9241 3731 e: mail@costinroe.com.au w: costinroe.com.au




STORMWATER DRAINAGE DETAILS SHEET 2 CIVIL &

DRAWING TITLE


CO14521.01-DA 2-46

DESIGNED DRAWN DATE CHECKED SIZE SCALE CAD REF:
L IL AUG '22 DS A1 AS SHOWN C014521.01-DA2-46

STRUCTURAL **ENGINEERS** 

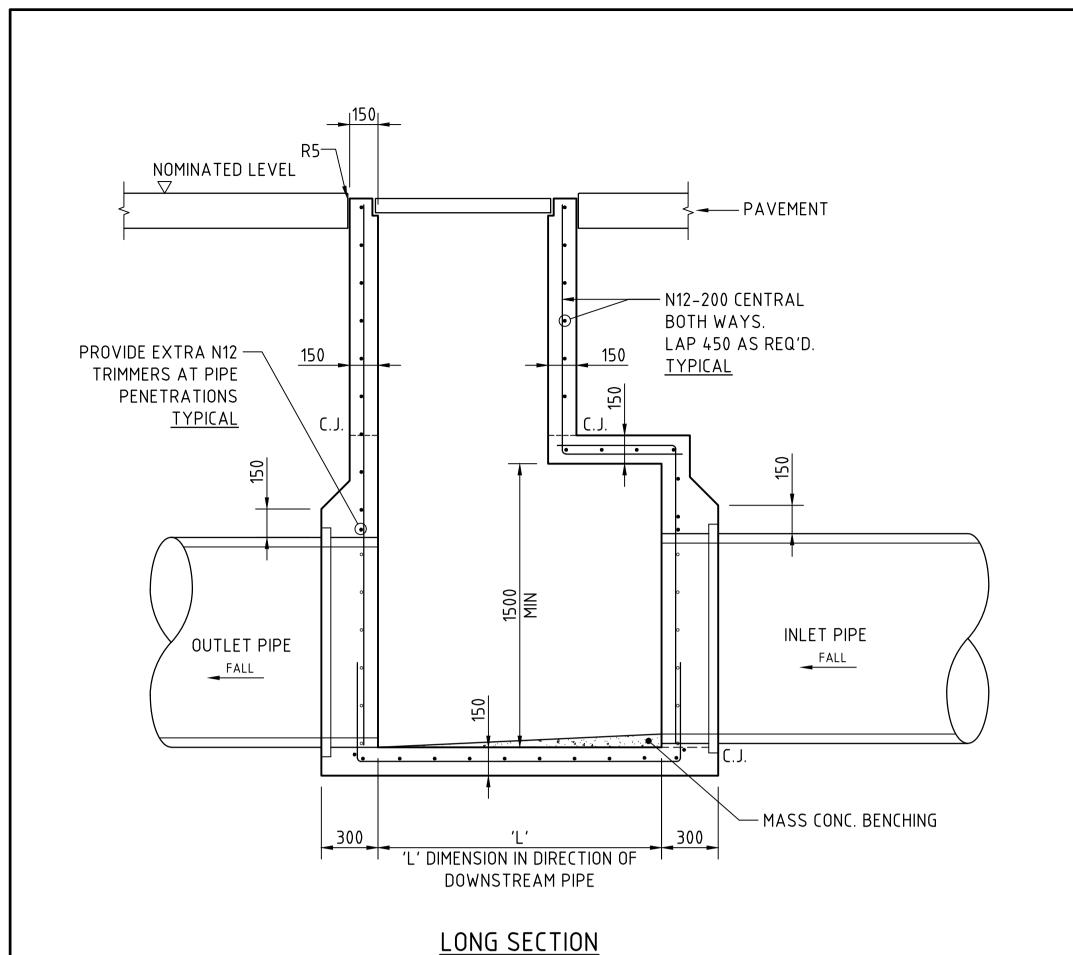

SCALE 1:20

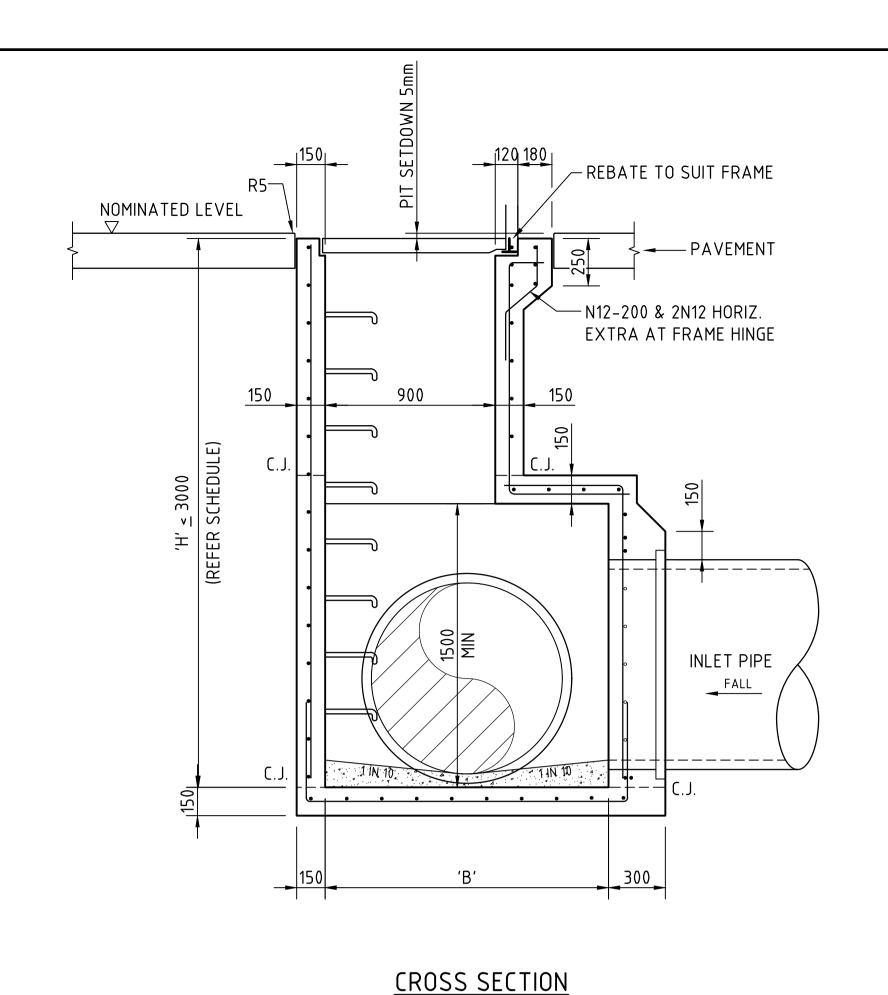

SCALE 1:20

-H.D. CAST IRON GRATE & TEE BAR FRAME 'GATIC' OR EQUAL SEE SCHEDULE

PLAN SCALE 1:20

## TAPERED SINGLE GRATED GULLY PIT - SGGP

SUBSOIL NOT SHOWN FOR CLARITY

# FOR DEVELOPMENT APPLICATION

2000mm SCALE 1:20 AT A1 SIZE SHEET

ARREHNEETT ISSUED FOR DEVELOPMENT APPLICATION 02.03.23 B ISSUED FOR INFORMATION 01.09.22 DATE ISSUE









Costin Roe Consulting Pty Ltd.
ABN 50 003 696 446 PO Box N419 Sydney NSW 1220

Level 4, 8 Windmill Street, Millers Point NSW 2000 p: +61 2 9251 7699 f: +61 2 9241 3731 e: mail@costinroe.com.au w: costinroe.com.au

CIVIL & STRUCTURAL **ENGINEERS** 

STORMWATER DRAINAGE DETAILS SHEET 3

DRAWING TITLE

DRAWING No CO14521.01-DA 2-47

